

## FEATURES & BENEFITS

### CONSTRUCTION

Unit is made of 18 gauge Type 304 stainless steel with a satin finish that resists stains and corrosion, and has soft, rounded corners. Unit features stainless steel satin finish back panel, vandal-resistant bottom plate, and 1-1/4" integral trap.

### HANDS OFF

Touchless operation for safety and peace of mind.

### BUBBLER HEADS

Polished chrome-plated brass bubbler heads with integral 11/16" dia. basin shank and stainless anti-rotation roll pin for vandal resistance strength. Shielded, angled stream opening provides a steady, sanitary source of drinking water at .45 gpm.

### FOUNTAIN VALVES

Fountain incorporates touchless sensor operated stainless steel solenoid valves controlled by a transformer for hands-free operation. A pressure regulator is used to adjust the bubbler flow according to incoming water pressures.

### VANDAL RESISTANT

The bubbler heads, drain strainers and bottom plates are locked in place, discouraging unwanted vandal tampering.

### INTEGRATED TRAP

All cast brass 1-1/4" NPT adjustable traps completely concealed inside bottom plates for easy installation and lack of unwanted access.



## SPECIFICATIONS

Model 1119H02 ADA vandal-resistant wall mounted motion-activated drinking fountain shall include dual 18 gauge Type 304 Stainless Steel satin finish basins, touchless sensor operated solenoid valves with 30-second obstruction time-out controlled by a transformer, 100% lead-free waterways, polished chrome-plated brass vandal-resistant bubbler heads, polished chrome-plated brass vandal-resistant waste strainers, vandal-resistant bottom plates, stainless steel satin finish back panel, high and low fountain mounting levels, and 1-1/4" NPT traps.

### FOR INDOOR USE ONLY

## OPTIONS

- Mounting Plate: Model 6700.4, in-wall mounting plate which is 36" wide by 3/16" thick solid steel that spans three studs for a heavy-duty vandal-resistant rigid installation.
- Support Frame: Model 6800 In-wall floor mounted fixture support legs, welded steel 4-bolt floor flanges, and supplied with 'U' bolts and hardware.
- Bottle Filler: Model 1920HO, bottle filler can be a stand-alone station, or mounted above Haws 1119 series drinking fountain models.
- Remote Drinking Fountain Water chiller: Model HCR8, 8 gph (30.3 L) remote water chiller provides instantaneous cooling to meet a continuous demand for chilled water.



For more information, visit [www.hawscos.com](http://www.hawscos.com) or call (888) 640-4297.


## APPLICATIONS

Perfect for either public or private indoor settings, the 1119H02 is a great fit in areas where aesthetics are important to the overall appeal of the architecture. Beautiful satin finish helps to maintain the fountains overall appeal. Specifically, this type of wall mounted drinking fountain may be placed in settings such as: schools and other locations in and around office buildings. Model meets all current Federal Regulations for the disabled including those in the Americans with Disabilities Act. Haws manufactures drinking fountains, faucets and electric water coolers to be lead-free by all known definitions including NSF/ANSI/CAN 61- Section 9, NSF/ANSI/CAN 372, California Proposition 65, and the Federal Safe Drinking Water Act. Product is compliant to California Health and Safety Code 116875 (AB 1953-2006), and 116876 (AB 100) "NSF/ANSI/CAN 61: Q ≤ 1".



- MODEL 1119HO SHOWN  
MODEL 1119HO2 ON SHEET 2  
(ROUGH-IN DIMENSIONS APPLY TO BOTH MODELS)

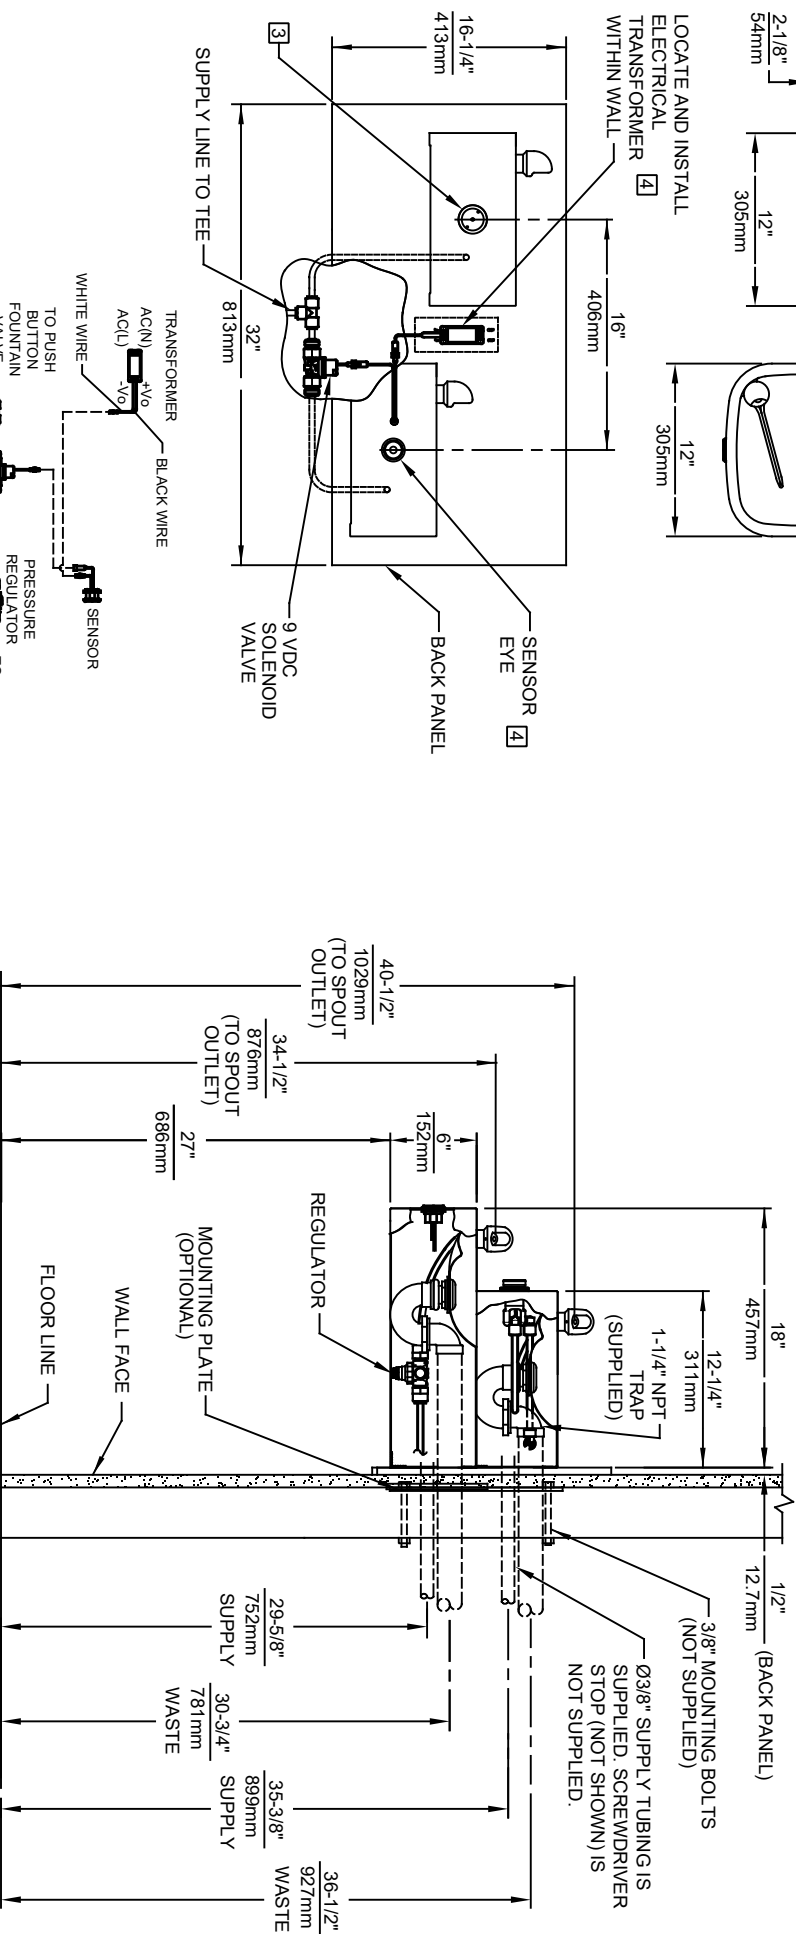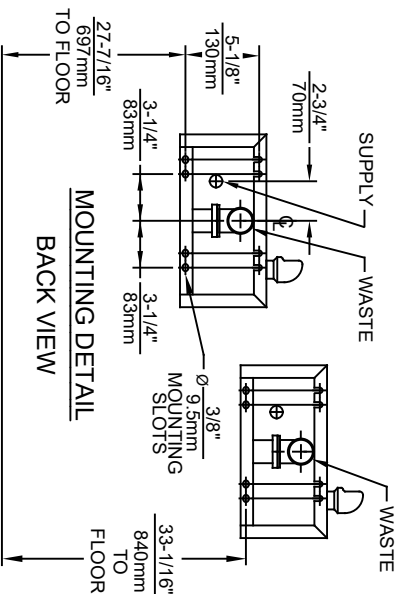

		<b>HAWMS®</b>		1455 KLEPPLE LANE SPARKS, NEVADA 89431 (775) 359-4712 FAX (775) 359-7424 E-MAIL: HAWMS@HAWMS.CO.COM WEBSITE: WWW.HAWMS.CO.COM	
ECN NO. REVISED PERBY: 5605 ECN: 5694 DP DRAWN: CHKO FV 10/23/00 DATE: 04/29/01		MODEL(S)  1119HO/1119HO2		PART NUMBER 0510001123.D REVISION 2	
SCALE: 1:14 DRAWING TYPE INSTALLATION SIZE: A SHEET 1 OF 2					



- POWER SPLITTER CABLE

4  
- SENSOR  
EYE

- BACK PANEL

4

9 VDC  
SOLENOID  
VALVES

EYE

MODEL 1119HO2 SHOWN  
MODEL 1119HO ON SHEET 1  
(SEE SHEET 1 FOR APPLICABLE ROUGH-IN DIMENSIONS)




FROM SUPPLY

五

## SENSOR WIRING / SUPPLY PLUMBING

### SCHEMATIC

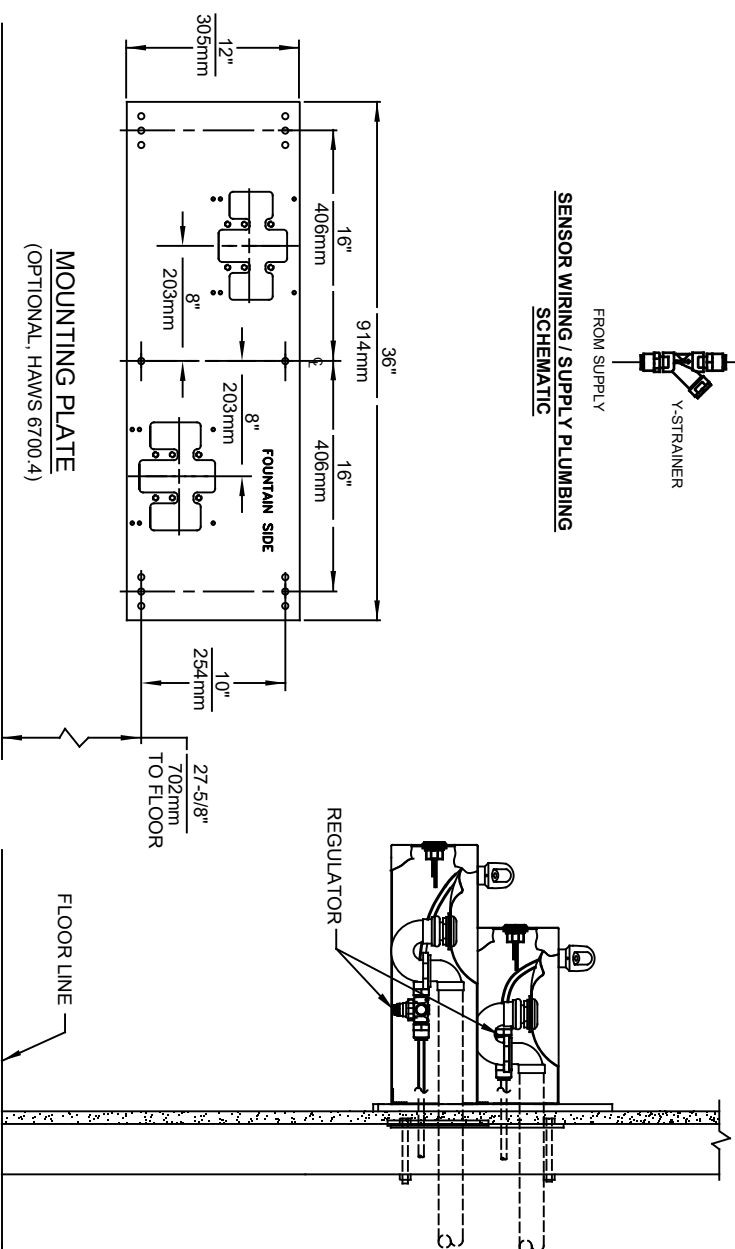

FLOOR LINE

REGULATOR

The drawing consists of two views of a mechanical assembly. View 'a' is a side elevation showing a vertical assembly with a top flange, a central shaft with a pulley, and a base. View 'b' is a front elevation showing the same assembly from a different perspective, highlighting the base and the central shaft. Both views include dimension lines and numerical values.



MODEL(S)

1119HO/1119HO2

ECN NO.	REVISED PER	BY:
5605	ECN: 5684	DP
DRAWN:	DATE:	CHKD:
EV	10/23/20	EV

APPROVED:	DATE:
-----------	-------

BUM	04/28/21
-----	----------

SCALE: 1:14	DRAWING TYPE:
-------------	---------------

## INSTALLATION

SIZE: A	SHEET 2 OF 2
---------	--------------

REVISION
----------

REVISION